## GENERAL NOTES

#### SHELTER DESIGN

THIS SHELTER HAS BEEN DESIGNED AS AN OPEN STRUCTURE. THE ADDITION OF ANY ENCLOSURE SUCH AS WALLS, INSECT MESH, OR SHADE SCREENS SHALL BE PROHIBITED AS INCREASED WIND FORCES MAY RESULT.

#### STEEL

STEEL PLATE SHALL CONFORM TO THE REQUIREMENTS OF ASTM A36.

HOLLOW STRUCTURAL SECTIONS (HSS) SHALL CONFORM TO THE REQUIREMENTS OF ASTM A500, GRADE B (Fy = 46 KSI).

WELDING SHALL CONFORM TO THE REQUIREMENTS OF THE AMERICAN WELDING SOCIETY'S SPECIFICATIONS FOR THE MATERIAL BEING WELDED.

WELDING ELECTRODES SHALL BE E70XX.

STRUCTURAL STEEL COMPONENTS SHALL BE COATED WITH ANTI-GRAFFITI POLYESTER TGIC POWDER COAT FINISH MEETING AAMA 2604-02 SPECIFICATION.

EXTRUDED ALUMINUM RIDGE CAP SHALL BE FABRICATED FROM ALUMINUM ALLOY 6105-T5 AND SHALL CONFORM TO THE REQUIREMENTS SHOWN ON THE DRAWING.

EXTRUDED ALUMINUM GUTTER FASCIA AND FASCIA TRIM SHALL BE FABRICATED FROM ALUMINUM ALLOY 6105-T5 OR 6061-T6 AND SHALL CONFORM TO THE REQUIREMENTS SHOWN ON THE DRAWING.

ALUMINUM COMPONENTS SHALL BE COATED WITH ANTI-GRAFFITI POLYESTER POWDER COAT FINISH MEETING AAMA 2604-02 SPECIFICATION.

#### **ROOF DECK**

INTERLOCKING SEAL ALUMINUM ROOF DECK SHALL BE ROLL FORMED FROM ALUMINUM ALLOY 3004-H36 AND SHALL CONFORM TO THE DECK PROFILE SHOWN ON THE DRAWING.

ROOF DECK SHALL BE COATED WITH HEAT REFLECTIVE BASF ULTRA-COOL COATING OR APPROVED EQUAL.

HIGH STRENGTH BOLTS SHALL CONFORM TO ASTM A325.

SCREWS ATTACHING TO STEEL SHALL BE 12-24 HEX WASHER HEAD #5 POINT SELF DRILLING SCREWS WITH BOND SEAL WASHER.

SCREWS ATTACHING TO ALUMINUM SHALL BE 8-18 HEX WASHER HEAD #2 POINT SELF DRILLING SCREWS.

HIGH STRENGTH BOLTS SHALL BE HOT DIP GALVANIZED. ALL SCREWS SHALL BE STAINLESS STEEL OR COATED WITH ZINC.

ALL BOLTS SHALL BE TIGHTENED TO A SNUG-TIGHT CONDITION AS DEFINED IN THE 2004 RESEARCH COUNCIL ON STRUCTURAL CONNECTIONS (RCSC) SPECIFICATION FOR STRUCTURAL JOINTS USING A325 OR A490 BOLTS.

## SHOP FABRICATION AND FIELD ASSEMBLY

ALL STRUCTURAL STEEL AND ALUMINUM COMPONENTS SHALL BE SHOP FABRICATED SO THAT FIELD ASSEMBLY OF CONNECTIONS CAN BE PERFORMED USING ONLY BOLTING AND SCREW PLACEMENT.


ALL SHOP WELDING TO BE PERFORMED BY AWS CERTIFIED WELDERS.

ALL SHOP WELDS SHALL BE IN STRICT ACCORDANCE WITH THE STRUCTURAL WELDING CODE AWS D1.1 OF THE AMERICAN WELDING SOCIETY SPECIFICATIONS. ALL STRUCTURAL WELDS SHALL BE IN COMPLIANCE WITH THE REQUIREMENTS OF "PRE-QUALIFIED" WELDED JOINTS. ALL WELDING SHALL CONFORM TO AWS A5.18: ER70S-6 SERIES E70XX **ELECTRODES - LOW HYDROGEN.** 

FIELD WELDING SHALL NOT BE REQUIRED.

### SPECIAL INSPECTIONS

THIS SHELTER IS CLASSIFIED AS AN ACCESSORY AND/OR MISCELLANEOUS STRUCTURE AND SHALL BE CONSIDERED CONSTRUCTION OF A MINOR NATURE. THEREFORE SPECIAL INSPECTIONS SHALL NOT BE REQUIRED PER IBC 1704.2.

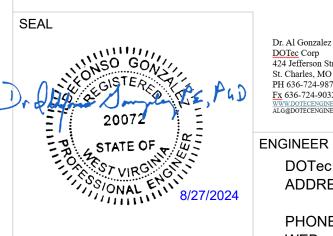

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www.americana.com

273 WOODBURY AVE. MARTINSBURG, WV 25404

PROJECT / LOCATION

24' x 50'

**MODEL** 

**ILLINI SHELTER** 

JOB NO. P.O. NO.

DRAWN DATE DWG. NO. DRAWN BY 222129 TG 8/19/2024 222129 CHECKED BY **REVISE DATE** P24-188 ΑY

SHEET

**C1** 

OF 16 SHEETS

## CONTENTS

C1 COVER SHEET

S1 PLAN AND ELEVATIONS

S2 FOUNDATION PLAN AND SECTION

S3 STRUCTURAL FRAMING S4 FRAMING CONNECTION DETAILS

S5 ROOFING DETAILS

D1-D10 STEEL FABRICATION DETAILS

**ROOF LIVE LOAD: 20 PSF GROUND SNOW LOAD: 35 PSF ROOF SNOW LOAD: 29.4 PSF** BASIC WIND SPEED: 115 MPH (3 SECOND GUST) WIND EXPOSURE: C SOIL BEARING STRENGTH: 1500 PSF SOIL SITE CLASS: D (ASSUMED) SEISMIC SS: 0.121 SEISMIC S1: 0.043 SEISMIC SDS: 0.129

DESIGN PARAMETERS

**BUILDING CODES:** 

ROOF DEAD LOAD: 5 PSF

2018 IBC

**ASCE 7-16** 

SEISMIC DESIGN CATEGORY: B TRANSVERSE SEISMIC RESISTING SYSTEM: STEEL ORDINARY MOMENT FRAME

TRANSVERSE RESPONSE MODIFICATION FACTOR: 3.50 TRANSVERSE SEISMIC RESPONSE COEFFICIENT: 0.037


LONGITUDINAL SEISMIC RESISTING SYSTEM: STEEL ORDINARY CANTILEVER COLUMN


LONGITUDINAL RESPONSE MODIFICATION FACTOR: 1.25 LONGITUDINAL SEISMIC RESPONSE COEFFICEINT: 0.103 SEISMIC ANALYSIS PROCEDURE: EQUIVALENT LATERAL FORCE

# **BUILDING DATA**


**SEISMIC SD1: 0.069** 

OCCUPANCY CLASSIFICATION: U (ACCESSORY / MISC.) RISK CATEGORY: II CONSTRUCTION TYPE: II-B FLOOR AREA: 1200 SQ. FT. OCCUPANCY LOAD: 7 SQ. FT. / OCCUPANT = 171 OCCUPANTS

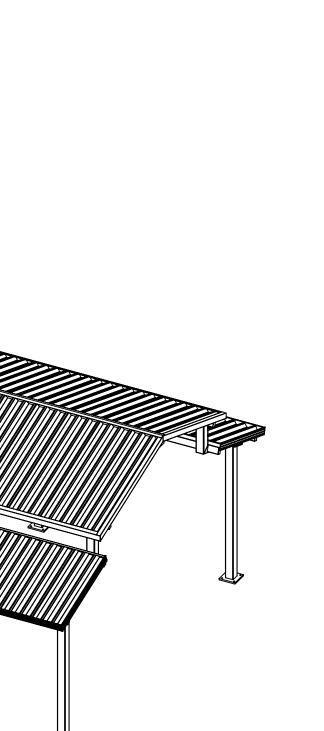

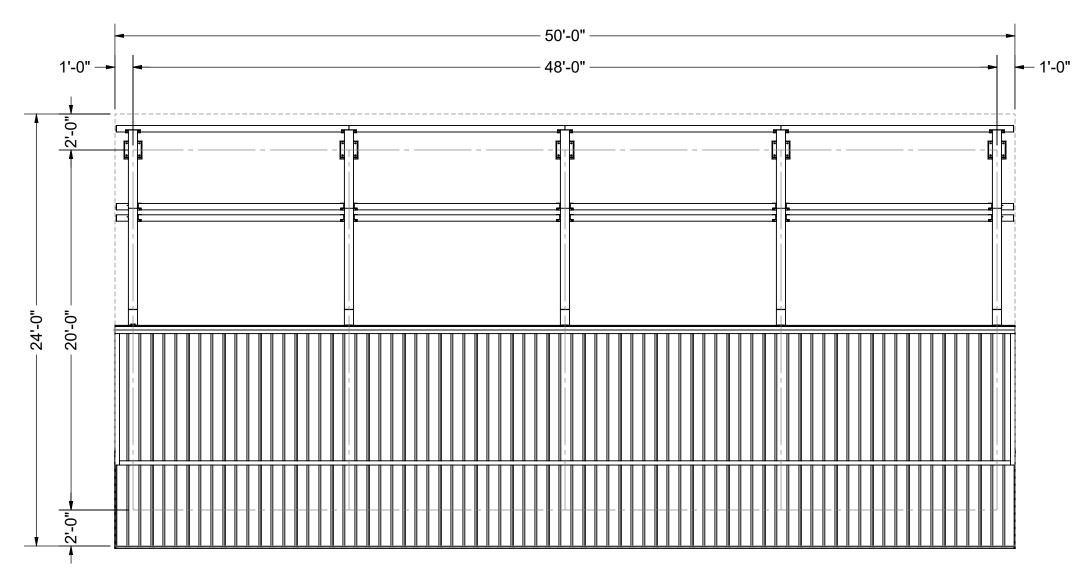

ROOF PLAN Scale: 3/16" = 1'-0"

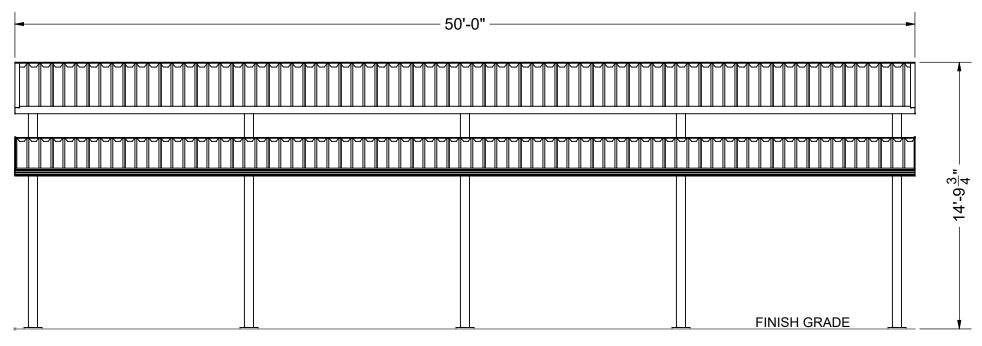

SIDE ELEVATION
Scale: 3/16" = 1'-0"



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FRONT ELEVATION
Scale: 3/16" = 1'-0"

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PROJECT / LOCATION

24' x 50'

ILLINI SHELTER

MODEL

DWG. NO. DRAWN BY 222129 TG JOB NO. 222129 CHECKED BY P.O. NO. P24-188 AY

DRAWN DATE SHEET 8/19/2024 **S**1 **REVISE DATE** OF 16 SHEETS

# **NOTES**

### **FOUNDATION**

THE FOUNDATION SHALL REST ON SOUND SOIL THAT IS FREE OF ORGANIC AND DELETERIOUS MATERIALS AND CAPABLE OF SUPPORTING 1500 PSF VERTICAL BEARING PRESSURE AND 100 PSF/FT LATERAL BEARING PRESSURE.

FOUNDATION DESIGN SHOWN IS BASED ON THE MINIMUM PRESUMPTIVE SOIL STRENGTHS FROM THE SPECIFIED BUILDING CODE. OWNER SHALL VERIFY ACTUAL SOIL CONDITIONS AT EACH JOB SITE AND ANY REQUIRED ADJUSTMENTS TO THE FOUNDATION DESIGN SHALL BE DESIGNED BY OTHERS.

IF NECESSARY, EXTEND DEPTH OF FOOTING TO MEET LOCAL FROST DEPTH REQUIREMENTS AND ADD TIES TO MEET THE SPACING REQUIREMENT STATED ON THE DRAWING.


#### **CONCRETE**

COMPRESSION STRENGTH OF ALL REINFORCED CONCRETE SHALL NOT BE LESS THAN 3500 PSI AT 28 DAYS.

REINFORCING BARS SHALL BE DEFORMED BARS CONFORMING TO THE REQUIREMENTS OF MINIMUM ASTM A615 GRADE 40 FOR #4 AND SMALLER BARS AND GRADE 60 FOR BARS LARGER THAN #4.

MINIMUM CONCRETE COVER FOR REINFORCING BARS SHALL BE 3" UNLESS NOTED OTHERWISE.


ANCHOR RODS SHALL BE ASTM F1554 GRADE 36 MINIMUM, GALVANIZED ROD, HEADED OR WITH HEAVY HEX NUT TACKED TO ROD.

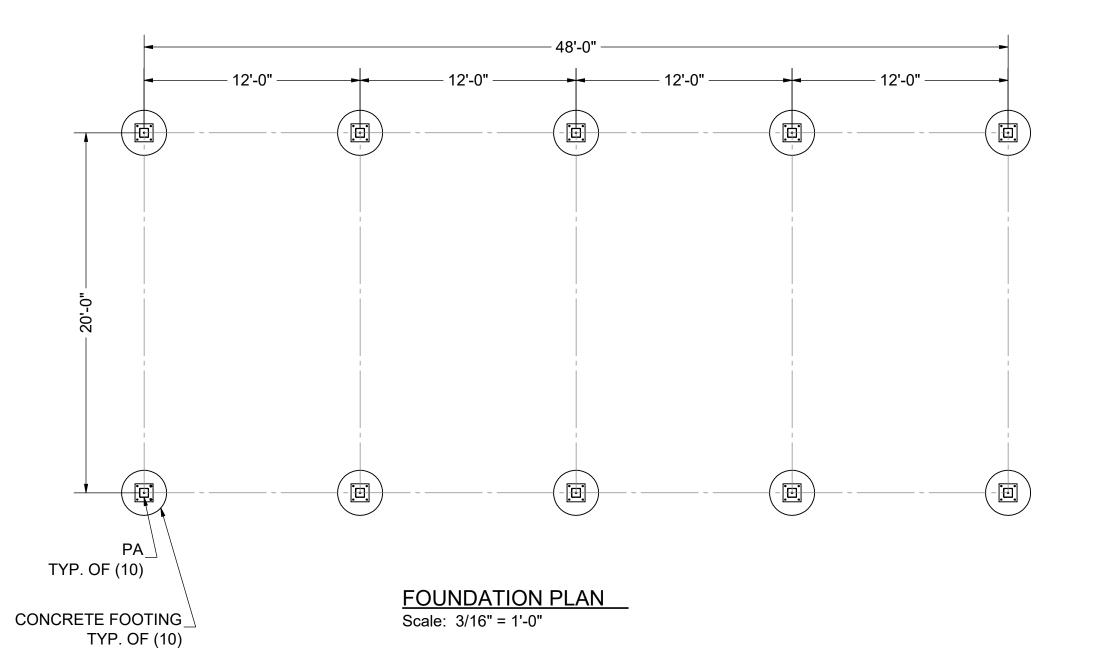


# **FOUNDATION REACTIONS (ASD MAX.)**


AXIAL: 6.394 KIP UPLIFT: 0.734 KIP LATERAL: 1.100 KIP MOMENT: 0.637 K-FT

NOTE: FOOTING DESIGNED AS CONSTRAINED

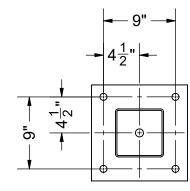

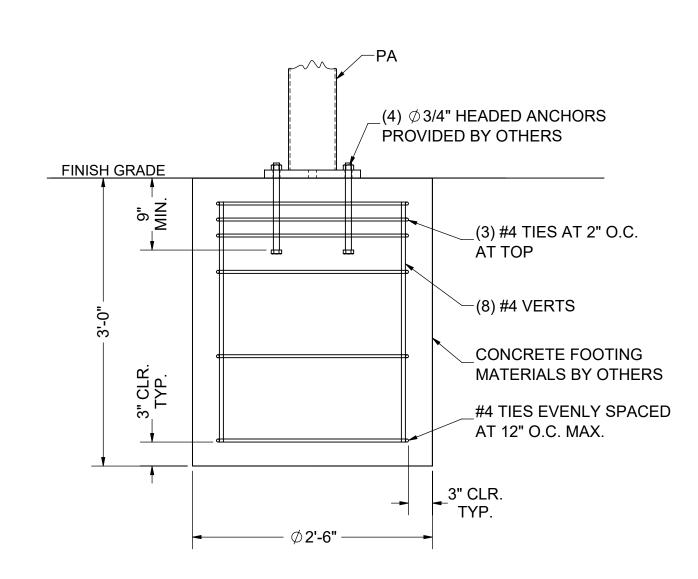

FOUNDATION SECTION Scale: 1" = 1'-0"

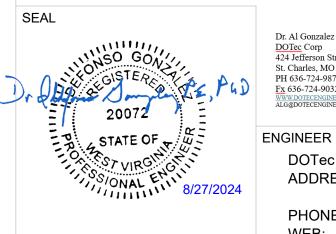

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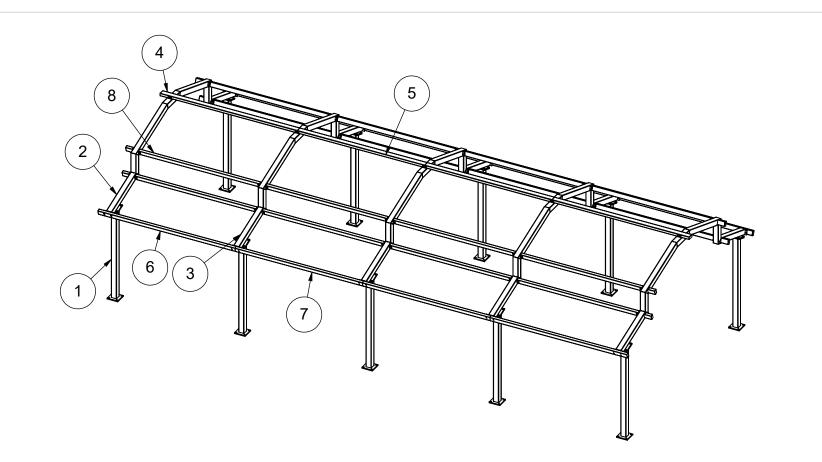
PROJECT / LOCATION

MODEL


24' x 50' **ILLINI SHELTER** 

DWG. NO.	222129	DRAWN BY	DRAWN DATE
JOB NO.	222129	TG	8/19/2024
		CHECKED BY	REVISE DATE
P.O. NO.	P24-188	AY	


SHEET S2




TEM NO.	QTY.				
	QII.	PART NO.	DESCRIPTION	MATERIAL	EST. WEIGHT (LBS)
1	10	PA	POST	HSS 6x6x3/16"	188.48
2	2	RA	RAFTER	HSS 6x6x3/16"	467.12
3	3	RB	RAFTER	HSS 6x6x3/16"	452.89
4	2	TA	RIDGE BEAM	HSS 6x3x3/16"	136.91
5	2	ТВ	RIDGE BEAM	HSS 6x3x3/16"	126.6952
6	4	EA	EDGE BEAM	HSS 5x3x1/8"	82.68
7	4	EB	EDGE BEAM	HSS 5x3x1/8"	76.4117
8	16	SA	PURLIN	HSS 5x3x1/8"	72.69
	3 4 5 6 7	2 2 3 3 4 2 5 2 6 4 7 4	2 2 RA 3 3 RB 4 2 TA 5 2 TB 6 4 EA 7 4 EB	2       2       RA       RAFTER         3       3       RB       RAFTER         4       2       TA       RIDGE BEAM         5       2       TB       RIDGE BEAM         6       4       EA       EDGE BEAM         7       4       EB       EDGE BEAM	2       2       RA       RAFTER       HSS 6x6x3/16"         3       3       RB       RAFTER       HSS 6x6x3/16"         4       2       TA       RIDGE BEAM       HSS 6x3x3/16"         5       2       TB       RIDGE BEAM       HSS 6x3x3/16"         6       4       EA       EDGE BEAM       HSS 5x3x1/8"         7       4       EB       EDGE BEAM       HSS 5x3x1/8"

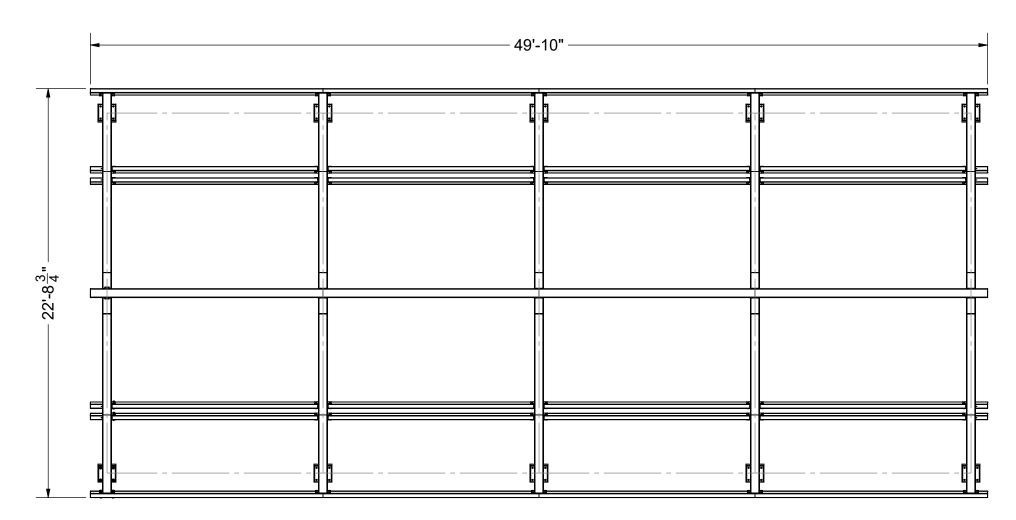

FRAME PLAN Scale: 3/16" = 1'-0"

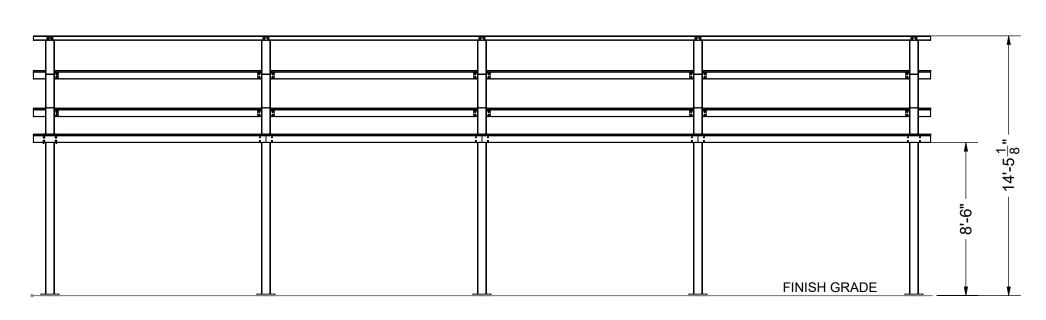

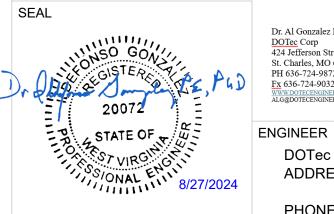

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FRAME ELEVATION

Scale: 3/16" = 1'-0"

PROJECT / LOCATION

273 WOODBURY AVE.

MODEL

24' x 50'

DWG. NO. DRAWN BY 222129 JOB NO.

222129

P.O. NO.

DRAWN DATE TG 8/19/2024 CHECKED BY **REVISE DATE** P24-188 AY

FRAME ELEVATION

Scale: 3/16" = 1'-0"

SHEET **S**3

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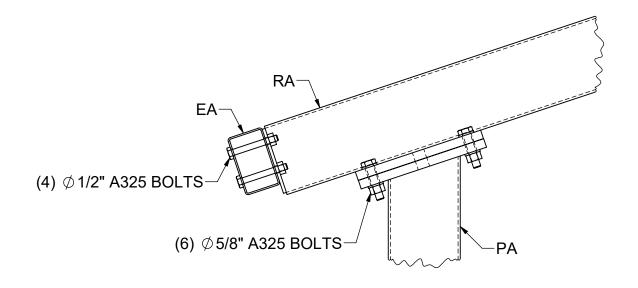
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AMERICANA OUTDOORS


MANUFACTURER

MARTINSBURG, WV 25404

ILLINI SHELTER




FRAME SECTION AT POST Scale: 1-1/2" = 1'-0"

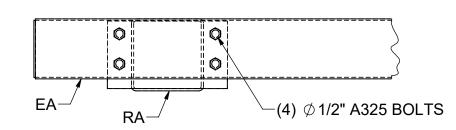


FRAME SECTION AT EDGE BEAM

Scale: 1-1/2" = 1'-0"

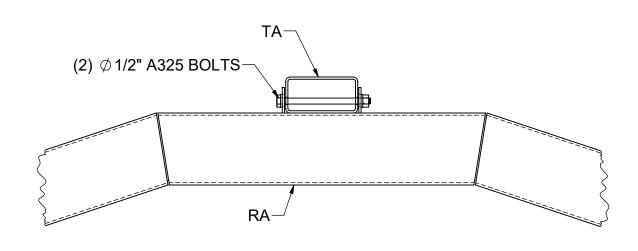


FRAME SECTION AT RIDGE

Scale: 1-1/2" = 1'-0"

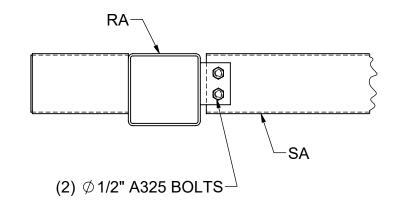

FRAME SECTION AT PURLIN

Scale: 1-1/2" = 1'-0"

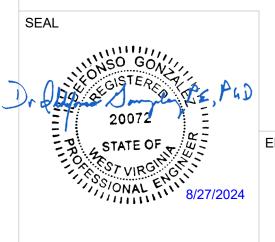

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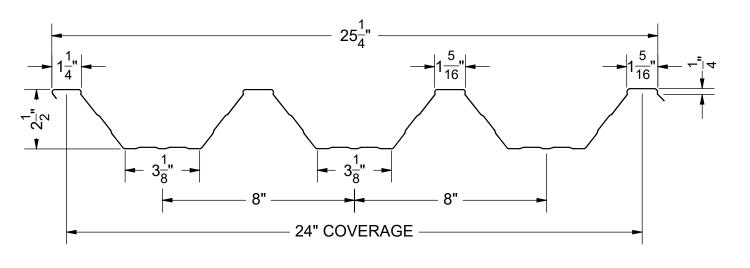
PROJECT / LOCATION

24' x 50' ILLINI SHELTER

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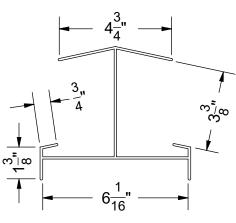
DRAWN DATE SHEET 8/19/2024 **S4 REVISE DATE** OF 16 SHEETS



**ALUMINUM 3004-H36** THICKNESS= .038"

ROOF DECK PROFILE


Scale: 2" = 1'-0"



ALUMINUM ALLOY 6105-T5 THICKNESS= .094"


RIDGE TRIM PROFILE

Scale: 3" = 1'-0"

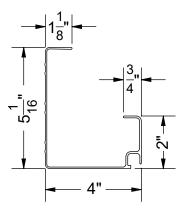

ALUMINUM ALLOY 6105-T5 THICKNESS= .062"


**GUTTER PROFILE** Scale: 3" = 1'-0"

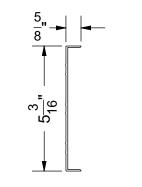

**ALUMINUM ALLOY 6061-T6** THICKNESS= .080"

FASCIA PROFILE


Scale: 3" = 1'-0"

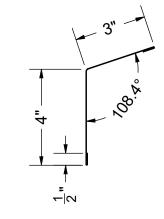

**ASTM A792 GALVALUME** THICKNESS= 24 GAUGE

**EAVE TRIM PROFILE** 


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**ASTM A792 GALVALUME** THICKNESS= 24 GAUGE

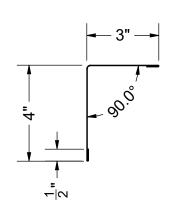RAKE TRIM PROFILE


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ASTM A792 GALVALUME THICKNESS= 24 GAUGE


CAP TRIM PROFILE

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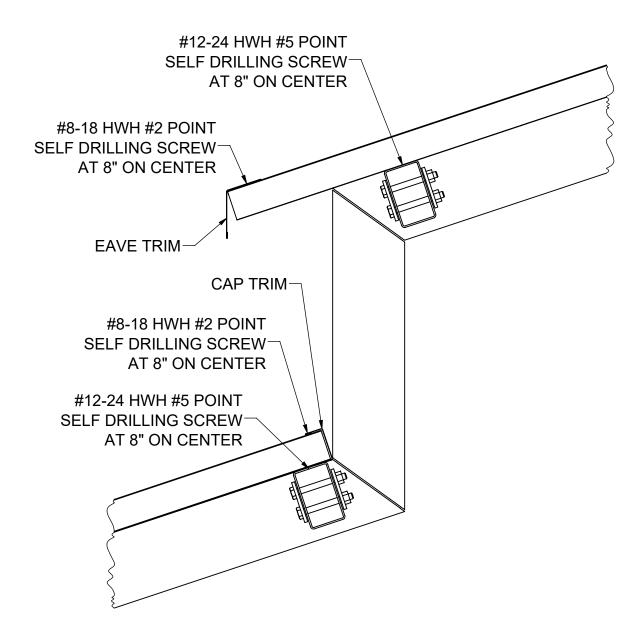
ROOF SECTION AT EAVE

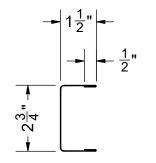Scale: 1-1/2" = 1'-0"

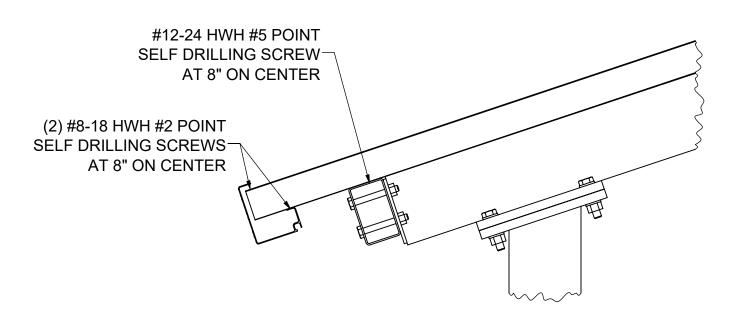

ROOF SECTION AT RIDGE

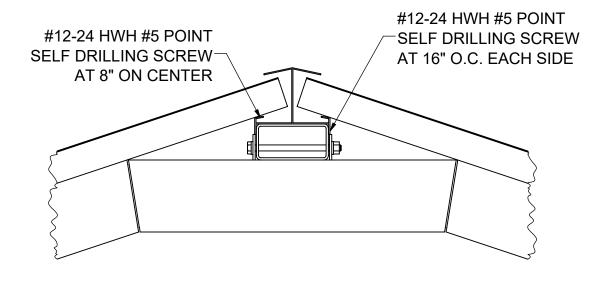Scale: 1-1/2" = 1'-0"




ROOF SECTION AT TRANSITION

Scale: 1-1/2" = 1'-0"

#8-18 HWH #2 POINT AT 12" ON CENTER #12-24 HWH #5 POINT SELF DRILLING SCREW AT 8" ON CENTER 0 0 0 0

ROOF SECTION AT RAKE

Scale: 1-1/2" = 1'-0"

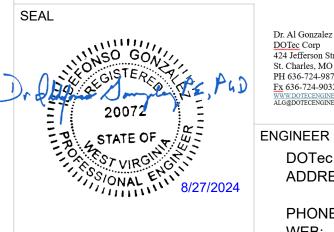

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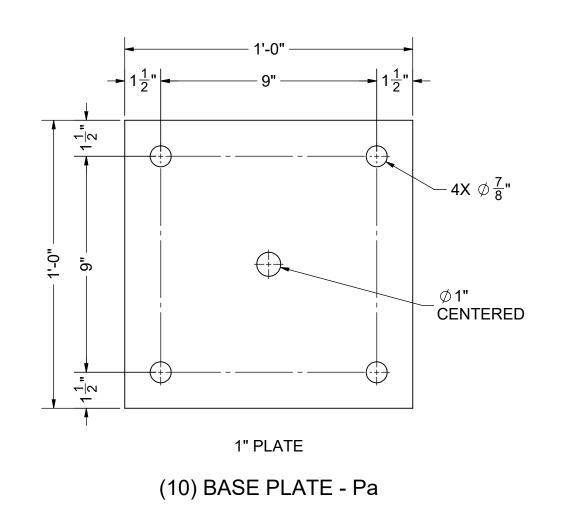
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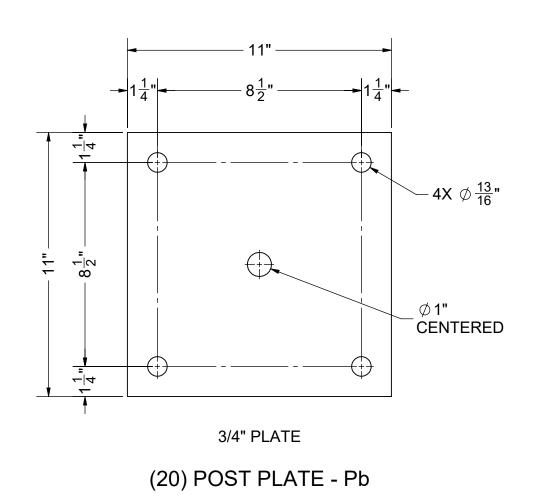
24' x 50' **ILLINI SHELTER** 


MODEL


DRAWN BY DRAWN DATE DWG. NO. 222129 TG 8/19/2024 JOB NO. 222129 CHECKED BY **REVISE DATE** P.O. NO. P24-188 ΑY

SHEET **S5** OF 16 SHEETS






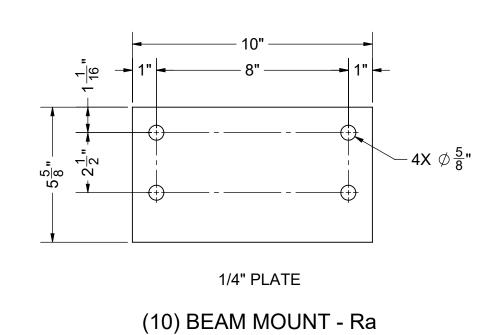


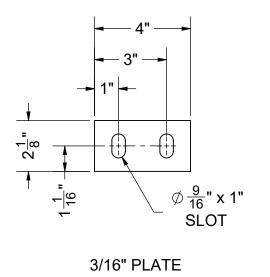

(10) BEAM MOUNT - RP8

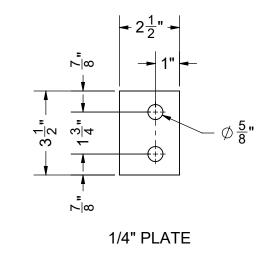


(64) PURLIN MOUNT - PM5

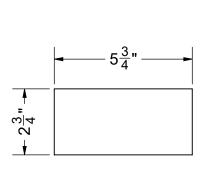


(2) CAP PLATE - PL1

1/8" PLATE

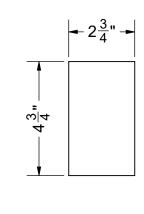

1/8" PLATE

(12) CAP PLATE - PL12

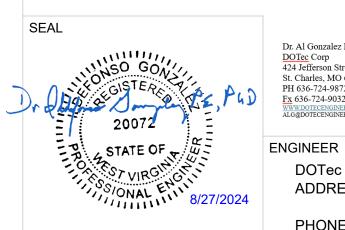

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PROJECT / LOCATION 273 WOODBURY AVE.

MARTINSBURG, WV 25404

24' x 50' ILLINI SHELTER

MODEL


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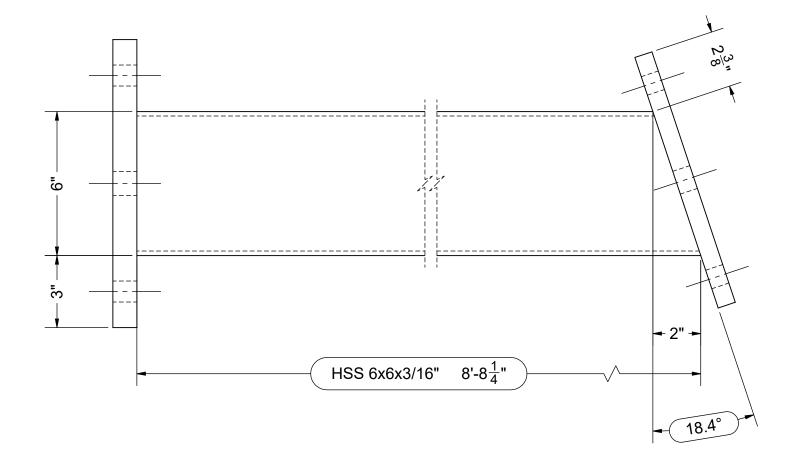
P24-188


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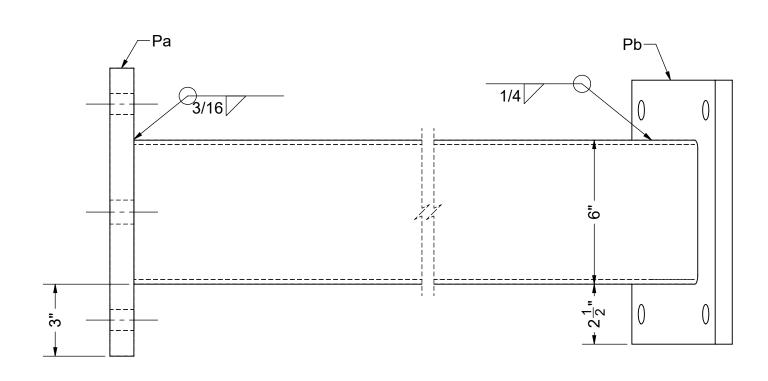
DRAWN DATE SHEET 8/19/2024 D1 REVISE DATE AY

PART QTY SHOWN IS FOR (1) SHELTER






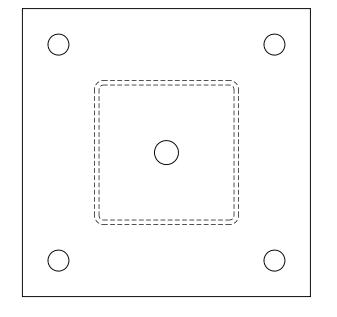

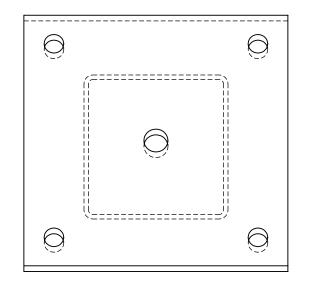

(10) POST - PA

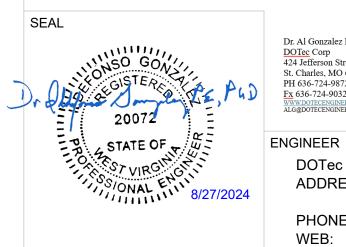

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24' x 50' ILLINI SHELTER

MODEL


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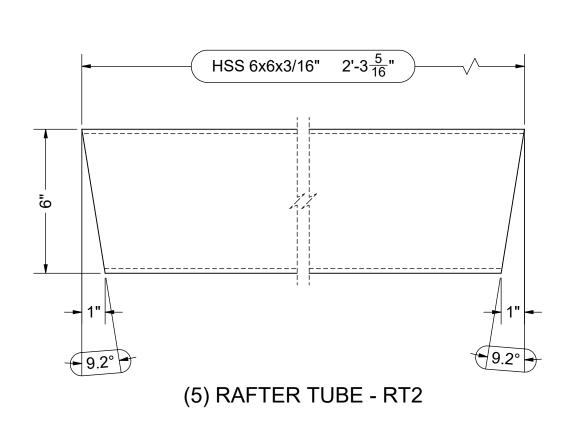
DRAWN BY DRAWN DATE 222129 8/19/2024 TG


PART QTY SHOWN IS FOR (1) SHELTER


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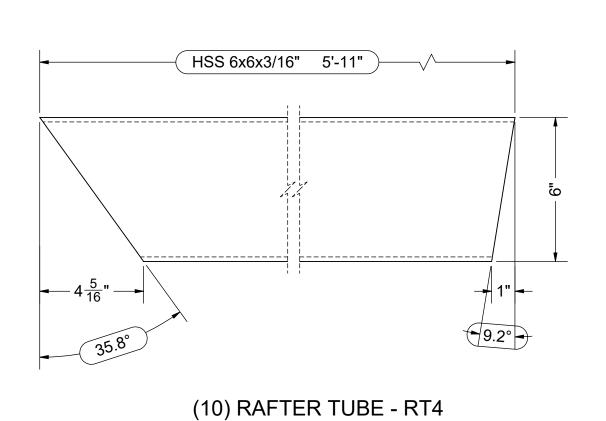
SHEET D2






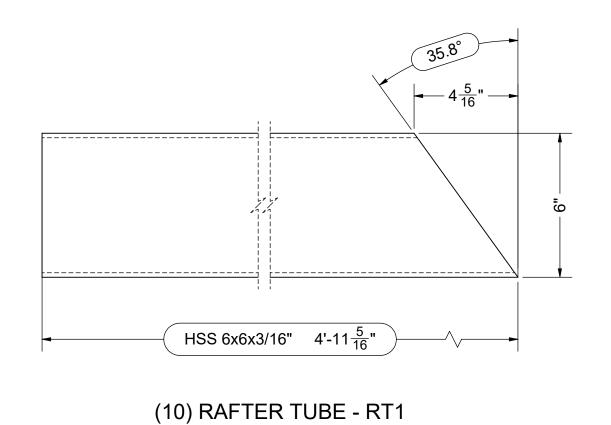

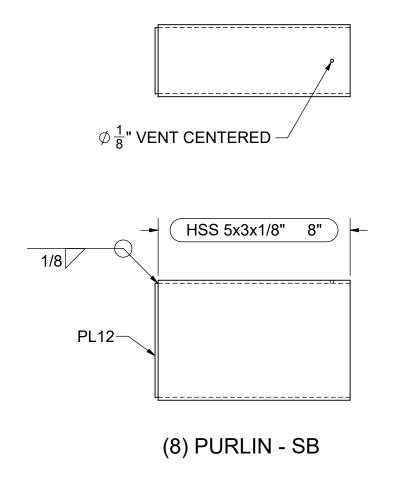

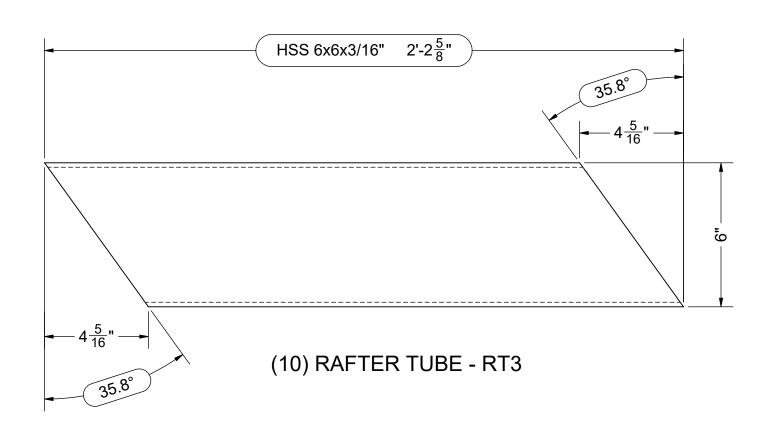

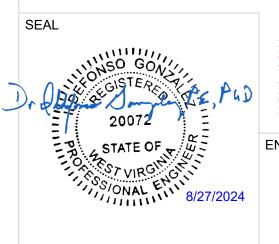

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ADDRESS: #2 INDUSTRIAL DRIVE SALEM, IL 62881 (800) 851-0865 PHONE: www.americana.com

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PROJECT / LOCATION


24' x 50' ILLINI SHELTER

MODEL

DWG. NO. 222129 JOB NO. 222129 P.O. NO.

DRAWN BY DRAWN DATE SHEET TG 8/19/2024 **D**3 CHECKED BY REVISE DATE P24-188 AY OF 16 SHEETS

PART QTY SHOWN IS FOR (1) SHELTER

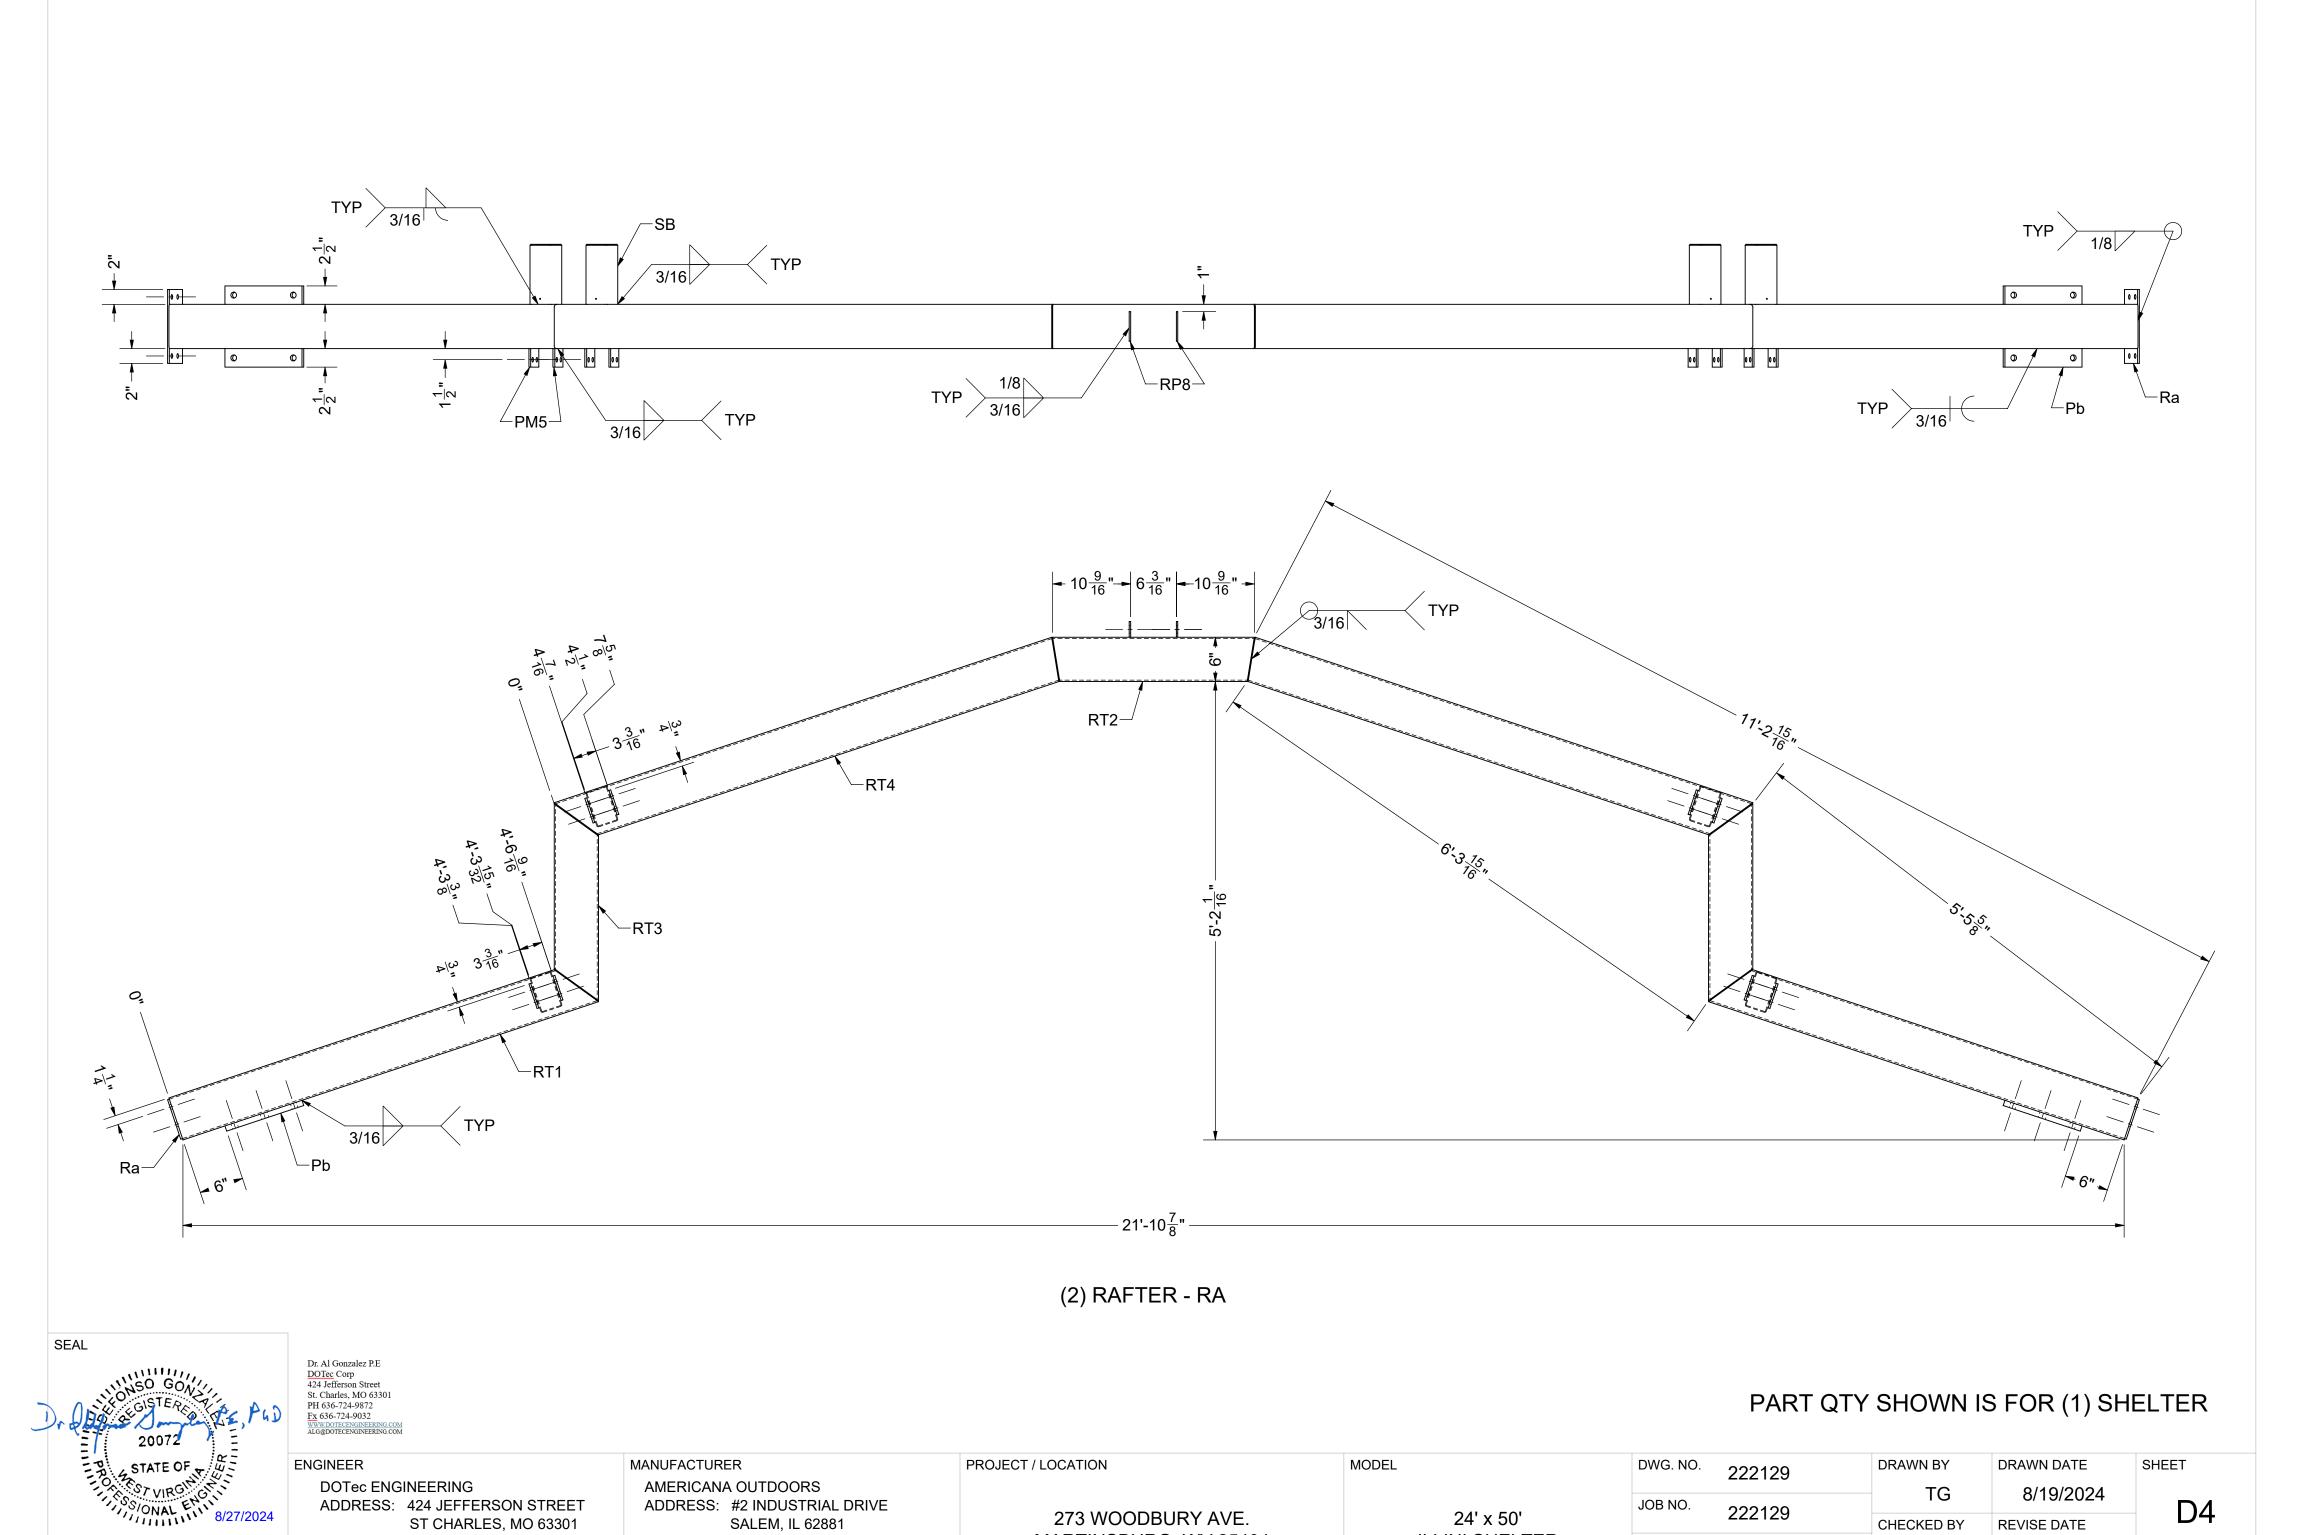

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PHONE:

24' x 50'

ILLINI SHELTER


P.O. NO.

P24-188

CHECKED BY

AY

**REVISE DATE** 

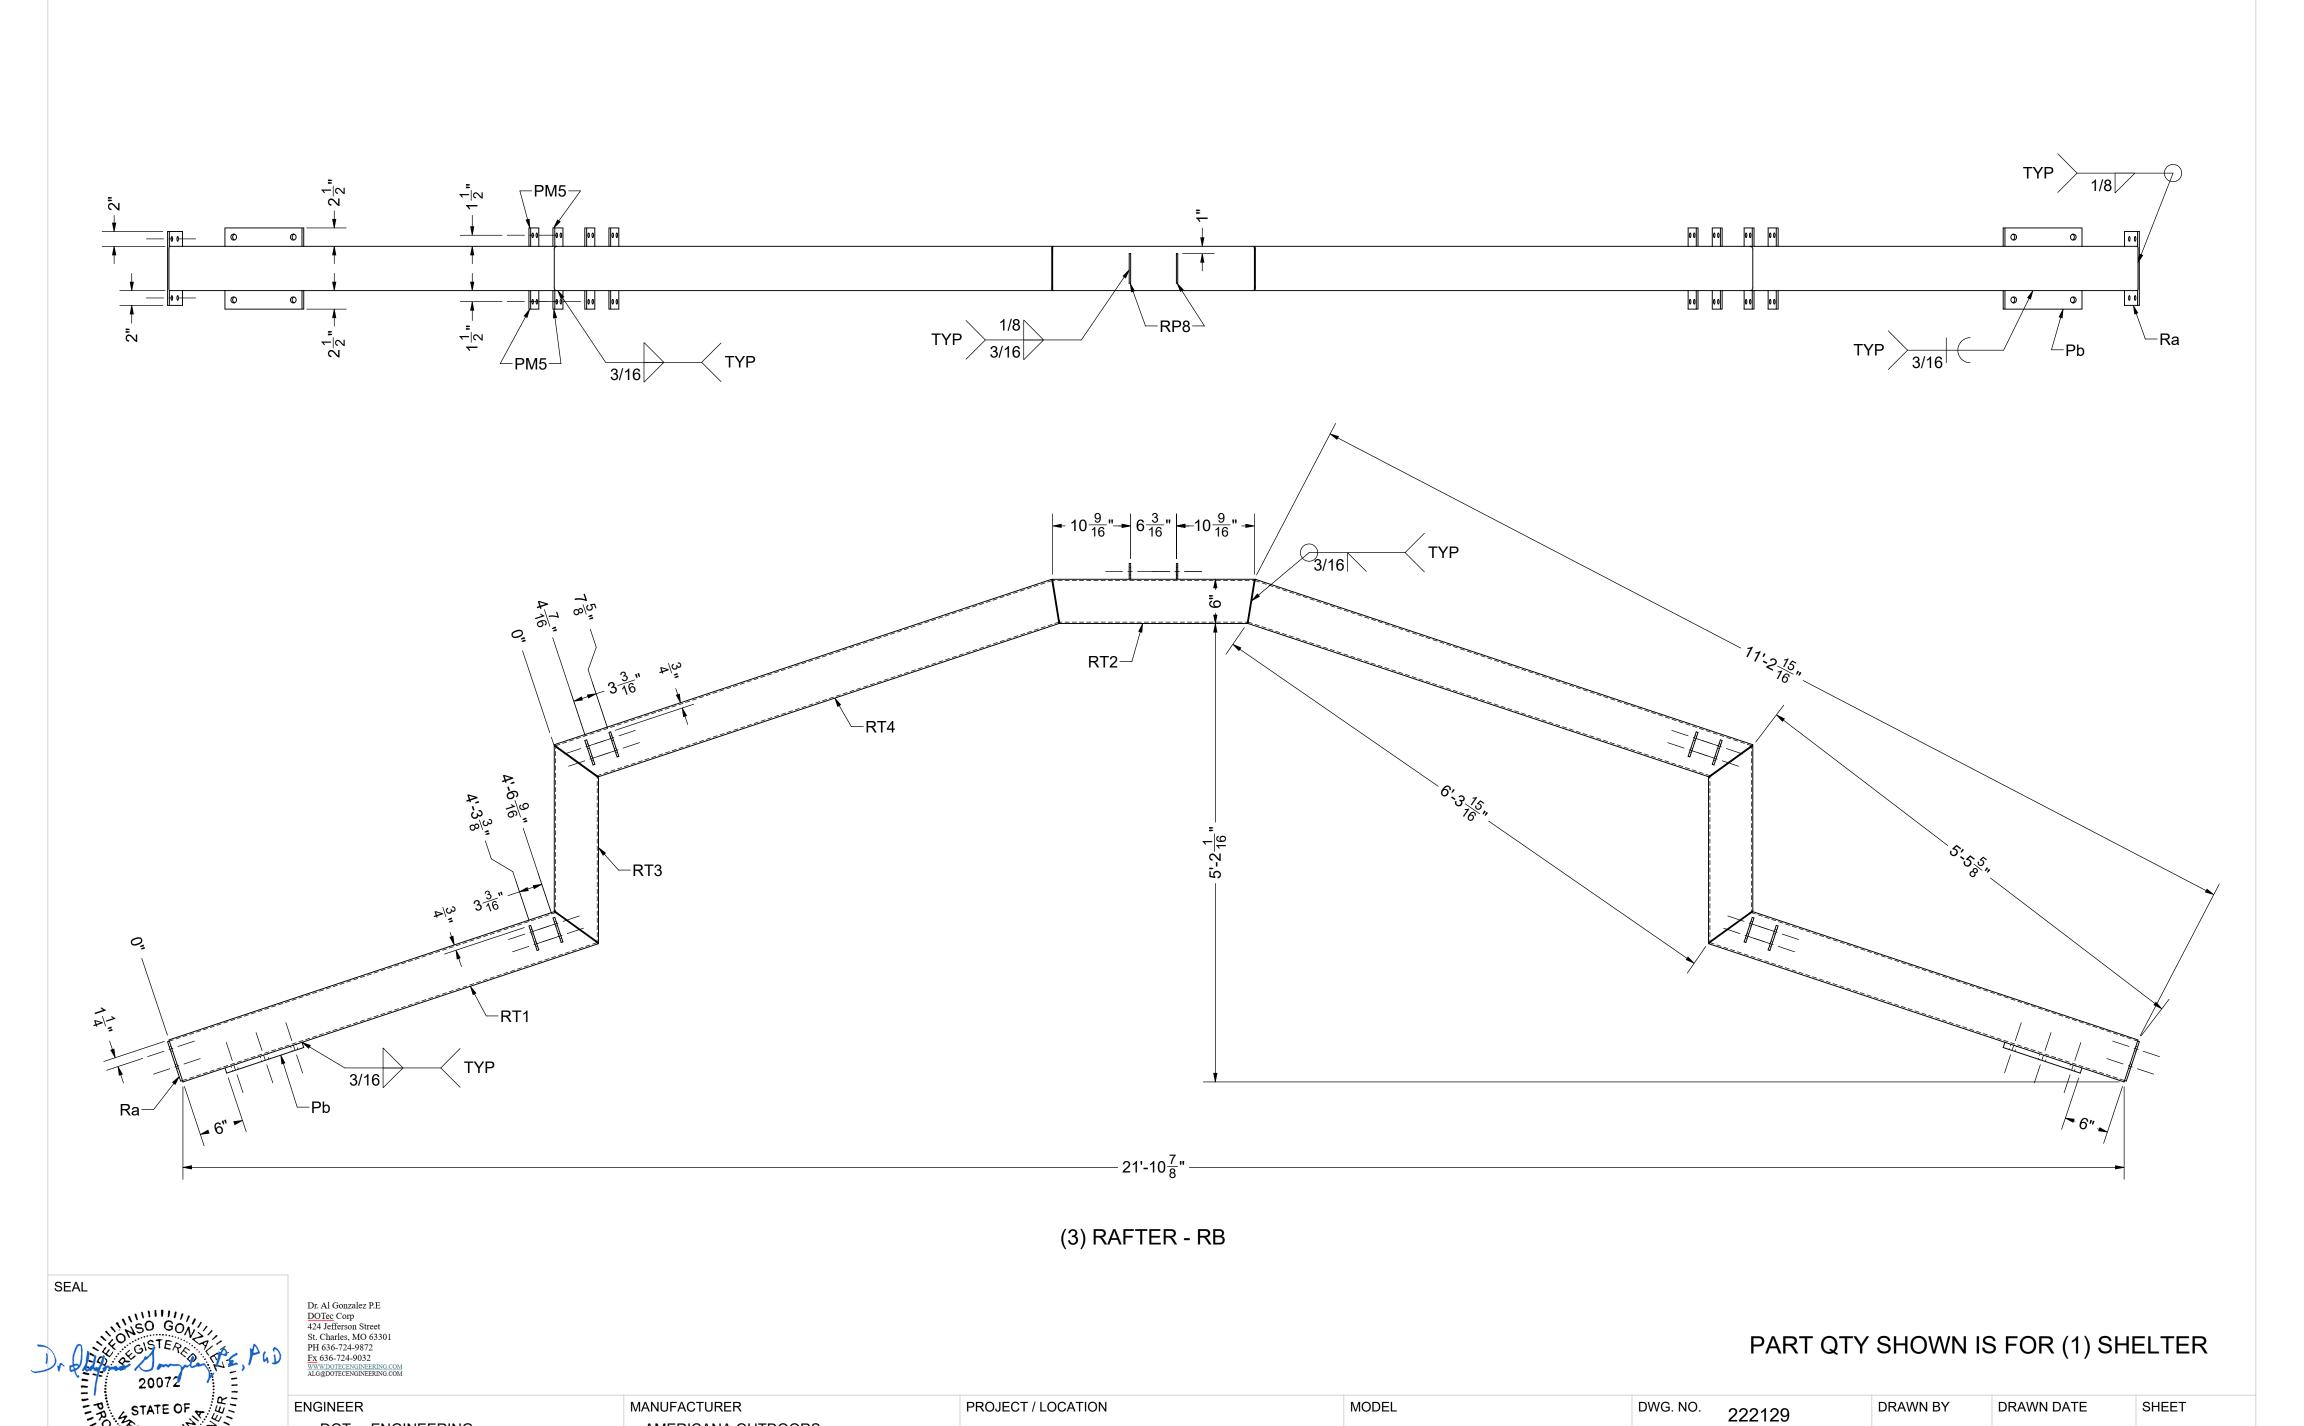

273 WOODBURY AVE.

MARTINSBURG, WV 25404

TG

AY

CHECKED BY

JOB NO.

P.O. NO.

24' x 50'

ILLINI SHELTER

222129

P24-188

8/19/2024

**REVISE DATE** 

**D5** 

OF 16 SHEETS

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AMERICANA OUTDOORS


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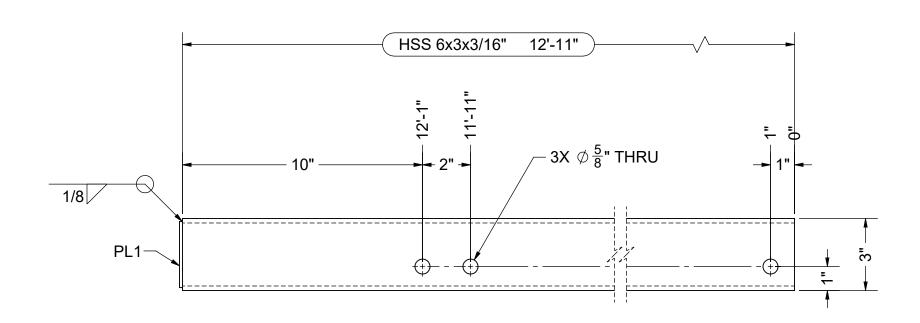
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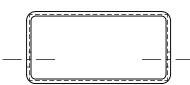
SALEM, IL 62881

www.americana.com


(800) 851-0865





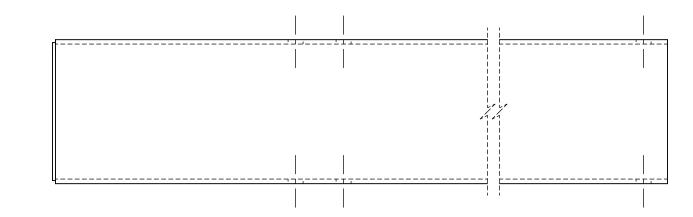

(2) RIDGE BEAM - TA

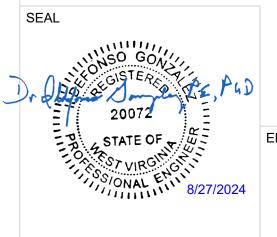

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MANUFACTURER

PROJECT / LOCATION 273 WOODBURY AVE.

MARTINSBURG, WV 25404

24' x 50' ILLINI SHELTER


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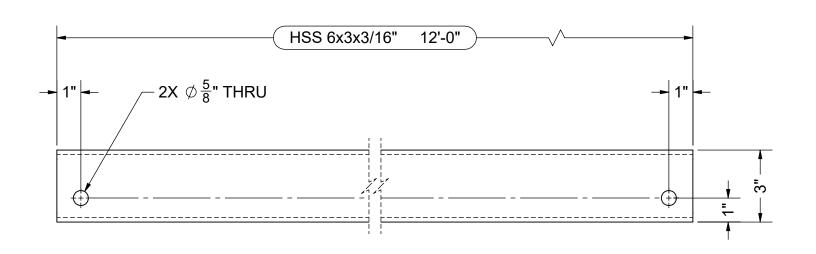
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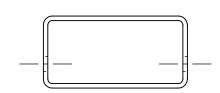
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PART QTY SHOWN IS FOR (1) SHELTER


SHEET D6 OF 16 SHEETS





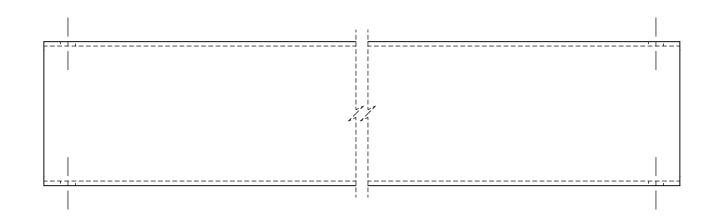

(2) RIDGE BEAM - TB

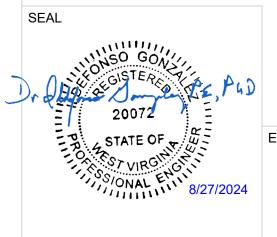

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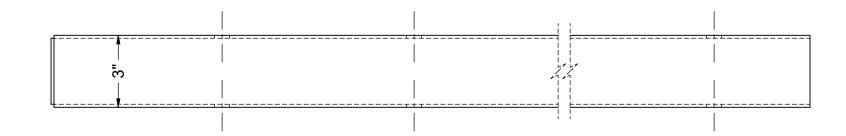
PROJECT / LOCATION


273 WOODBURY AVE. MARTINSBURG, WV 25404 MODEL


24' x 50' ILLINI SHELTER

PART QTY SHOWN IS FOR (1) SHELTER DRAWN DATE DWG. NO. DRAWN BY SHEET 222129

TG 8/19/2024 JOB NO. 222129 CHECKED BY REVISE DATE P.O. NO. P24-188 AY



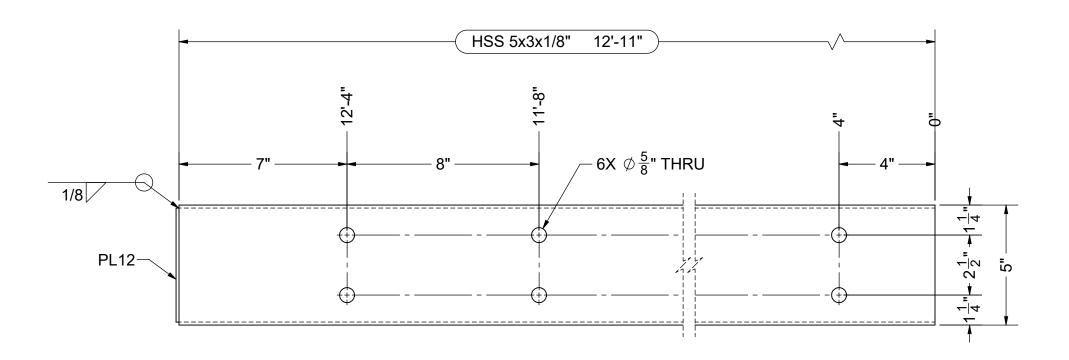

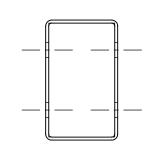

(4) EDGE BEAM - EA



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PROJECT / LOCATION 273 WOODBURY AVE.

MARTINSBURG, WV 25404

24' x 50' ILLINI SHELTER


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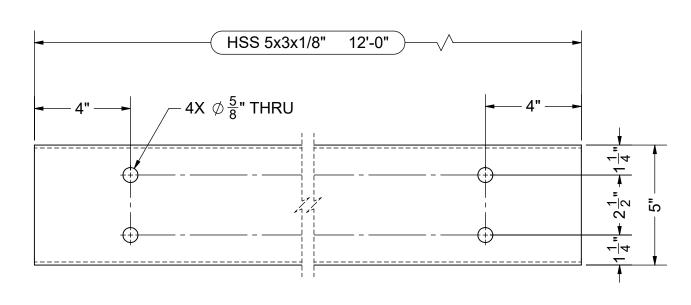
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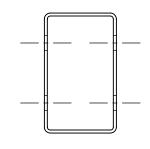
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DRAWN DATE SHEET TG 8/19/2024 D8 CHECKED BY REVISE DATE AY OF 16 SHEETS


PART QTY SHOWN IS FOR (1) SHELTER





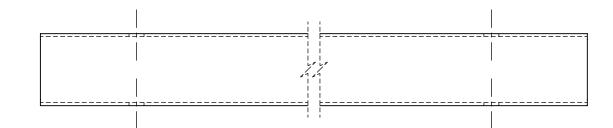

(4) EDGE BEAM - EB

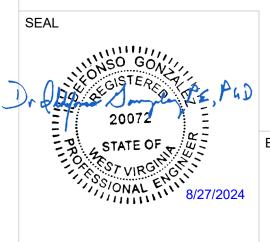

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MANUFACTURER

273 WOODBURY AVE. MARTINSBURG, WV 25404

PROJECT / LOCATION

24' x 50' ILLINI SHELTER


MODEL


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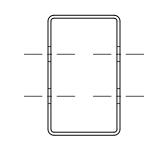
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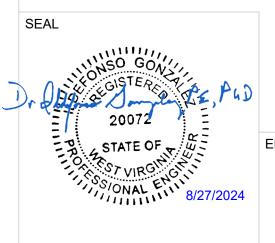
DRAWN DATE SHEET 8/19/2024 **D**9 REVISE DATE OF 16 SHEETS





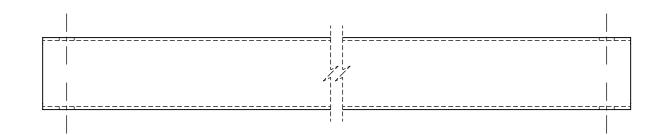

(16) PURLIN - SA

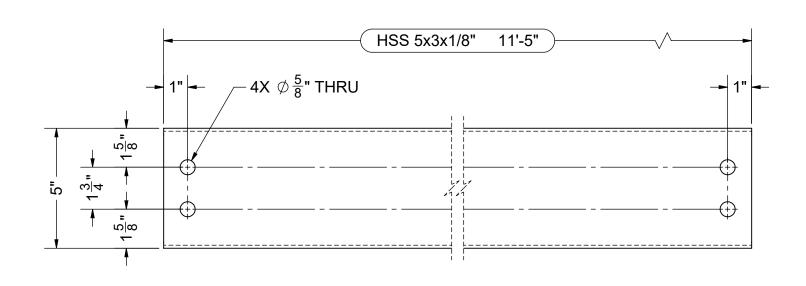

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PROJECT / LOCATION

273 WOODBURY AVE. MARTINSBURG, WV 25404 MODEL 24' x 50' ILLINI SHELTER

DWG. NO. JOB NO. P.O. NO.

DRAWN BY 222129 222129 CHECKED BY P24-188

DRAWN DATE SHEET TG 8/19/2024 D10 REVISE DATE AY

PART QTY SHOWN IS FOR (1) SHELTER